# ST BASIL'S HOMES

# **DEVELOPMENT APPLICATION PACKAGE**

Prepared for:

ST BASIL'S

Prepared by: Taylor Brammer Landscape Architects Pty Ltd

Drawing List	
DWG NO	DRAWING TITLE
L00	LANDSCAPE: COVER SHEET
L01	LANDSCAPE: GROUND LEVEL MASTER PLAN
L02	LANDSCAPE: GROUND LEVEL SECTION ELEVATIONS
L03	LANDSCAPE: LEVEL 3 MASTERPLAN & SECTION ELEVATION
L04	LANDSCAPE: TYPICAL CONSTRUCTION DETAILS

# SCALE NTS @ B1 1:200@B1 1:200@B1 1:200@B1 AS SHOWN @B1

# SPECIFICATION NOTES

1.0 SERVICES Before landscape work is commenced. The Landscape Contractor is to establish the position of all servicelines and ensure tree planting is to be carried out at least 3 metres away

from these services. Service lids, vents and hydrants shall be left exposed and not covered by any landscape finishes (turfing, paving, garden beds etc.) Finish adjoining surfa flush with pit lids.	
Dial Before You Dig - It is the landscape contractor's full responsibility to complete a full services search and take all required measures to ensure protection of these services including potholing to confirm locations. The client in no way will be held responsible for any damage caused to services as a result of the contract works.	i
Excavation Do not excavate by machine within 1m of existing underground services.	
2.0 SOILS	
Planting Mix Type A Location: All mass planting and tree planting in natural ground Type:Native Low'P' Mlx Supplier: Australian Native Landscape (tel: 131458)	
Planting Mix Type B Location: Semi mature tree planting Type: Sand-soil blend 50-50 Supplier: Australian Native Landscape (tel: 131458)	
RAISED PLANTER BOX MIXTURE Shall be homogenous blend of soil and additives in the following proportions: Type A - Smart Mix No 4 Type D - Smart Mix No 5 Supplier - Benedicts Industries	
RAISED PLANTER BOX MIXTURE FOR MATURE TREE PLANTING Shall be homogenous blend of soil and additives in the following proportions: Type A - Smart Mix No 4 Type B - Smart Mix No 5 Supplier - Benedicts Industries	
<ul> <li><b>3.0 MULCH</b></li> <li>APPLICATION: Place mulch to the required depth, (refer to drawings clear of plant stems, and rake to an even surface finishing 25mm below adjoining levels. Ensure mulch is tered in and tamped down during installation.</li> <li><b>MULCH TYPE:</b></li> <li>Mass Planting beds: Hort Bark (Supplier: A.N.L)</li> <li>Communal Garden: Clean Straw</li> <li>Reused Planters: Hardwood Chip (Supplier: A.N.L)</li> <li>Mulch Type: Shall be COTTAGE MULCH. Available from Soilco, Ph (02) 4272 9944</li> </ul>	; wa-
4.0 PLANTS SUPPLY	
The Landscape Contractor is responsible for organising the delivery of plant stock to site and checking plant stock prior to accepting delivery on site to ensure the plants sup possess the following characteristics:	oply
Large healthy root systems, with no evidence of root curl, restriction or damage.	

- Vigorous, well established, free from disease and pests, of good form consistent with the species or variety. Hardened off, not soft or forced, and suitable for planting in the natural climatic conditions prevailing at the site.
- Trees must, unless required to be multi-stemmed, have a single leading shoot. Any plants or trees that are accepted by the landscape contractor that do not meet this specification will be replaced at the contractor's expense. Replacement: Replace damaged or failed plants with plants of the same type and size.

# PLANTING

Do not plant in unsuitable weather conditions such as extremes of heat or cold, wind or rain. Before planting begins, complete cultivation, soil placement, fertilisation etc as previously specified.

Before plants are installed all pot sizes shall have their roots pruned with an appropriate, clean, sharp instrument to eliminate any root confusion occurring at edge of pot zone. Before planting begins, thoroughly water the plants and the planting area. Keep the area and plants moist during planting. Water the plants immediately after planting, and thereafter as required to maintain growth rates free of stress.

The contractor shall give notice, of not less than 24 hours, for inspections as nominated in inspect and hold point schedule

### ROOT PRUNING OF TREES

Remove tree from container and root prune 20mm on sides and bottom to ensure all circling roots have been either severed or aligned radially into the surrounding soil. Plant as per detail.

### 5.0 FERTILISER MASS PLANTING AREAS

Type: Nutricote Standard Black 270 Day (16: 4.4: 8.3) Installation: Evenly distribute 5g per litre (rootball size) of fertiliser onto backfill area around rootball prior to placing mulch.

### TREE PLANTING Type: Nutricote Standard Brown 360 Day blend (16: 4.4: 8.3)

Installation: Distribute 5q per litre (rootball size) of fertiliser into backfill around rootball. Apply in 3 evenly spread layers as hole is filled. First layer is to be half way up the rootball, second layer 3/4 up the rootball and third layer 50-100mm from the soil finished surface level. This application ensures that the nutrients leeches evenly downwards into the soil profile and encourages outward root system growth.

## 6.0 STAKING AND TYING

Stakes shall be straight plantation grown hardwood, free from knots and twists, pointed at one end and sized according to size of plants to be staked. a. 5-15 litre size plant 1x(1200x25x25mm)

## 35-75 litre size plant 2x(1500x38x38mm)


100-greater than 200 litre 3x(1800x50x50mm) Ties shall be 50mm wide hessian webbing or approved equivalent nailed or stapled to stake. Drive stakes a minimum one third of their length, avoiding damage to the root system, on the windward side of the plant.

## 7.0 GEOTEXTILE

Type: Polymeric fabric formed from a plastic yarn composed of at least 85% by weight of propylene, ethylene, amide or vinyledenechloride and containing stabilisers or inhibitors to make the filaments resistant to deterioration due to ultraviolet light. Identification and marking: To AS 3705.

## Product: Bidim A34

Recommended Supplier: Geofabrics Australia (Tel: 02 9821 3277).

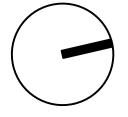

### MAINTENANCE PROGRAM Maintenance shall mean the care and maintenance of the landscape works by accepted horticultural practice as rectifying any defects that become apparent in the landscape works under normal use. This shall include, but shall not be limited to, watering, mowing, fertilising, reseeding, returfing, weeding, pest and disease control, staking and tying, replanting and plant

replacement, cultivation, pruning, aerating, renovating, topdressing, maintaining the site in a neat and tidy condition as follows:

The Landscape Contractor shall maintain the landscape works for the term of the maintenance (or plant establishment) period to the satisfaction of the Landscape Architect and Client. The

Landscape Contractor shall attend to the site on a weekly basis. The maintenance period shall commence at practical completion and continue for a period of twenty Six (26) weeks.

1.0 GENERAL	

# 2.0 WATERING

Grass and trees shall be watered regularly so as to ensure continuous healthy growth. Street trees and larger plant stock are to be watered through the top of the rootball to ensure a thorough soaking of the plant rootball. Watering of street trees shall be carried out on a weekly basis throughout the maintenance period regardless of rainfall. **3.0 RUBBISH REMOVAL** 

During the term of the maintenance period the Landscape Contractor shall ren regularly so that at weekly intervals the area may be observed in a completely of

4.0 REPLACEMENTS The Landscape Contractor shall replace all plants that are missing, unhealthy or the plant that has failed unless otherwise directed by the Landscape Architect seen to be missing. The landscape contractor is to report any evidence of theft

5.0 STAKES AND TIES The Landscape Contractor shall replace or adjust plant stakes and tree guards a maintenance period if so directed.

### 6.0 PRUNING Trees and shrubs shall be pruned as directed by the Landscape Architect. Pruni condition of the plants. Any damaged growth shall be pruned. All pruned mate

7.0 MULCHED SURFACES All mulched surfaces shall be maintained in a clean and tidy condition and be r stems at all times.

8.0 PEST AND DISEASE CONTROL The Landscape Contractor shall spray against insect and fungus infestation wit pests and diseases (immediately that they are detected) to the Landscape Arch

### 9.0 GRASS AND TURF AREAS The Landscape Contractor shall maintain all grass and turf areas by watering, w Apply lawn fertiliser as specified in fertilisers at the completion of the first and the fertilisation not less than seven (7) days before the end of the maintenance peri herbicide against broad leafed weeds as required by the Landscape Architect ar No fertiliser is to be used on turf areas. Grass and turf areas shall be kept mown to maintain a healthy and vigorous sw

**10.0 WEED ERADICATION** Eradicate weeds by environmentally acceptable methods using a non-residual Regularly remove by hand, weed growth that may occur or recur throughout g trees in grassed areas. Continue eradication throughout the course of the works

### 11.0 SOIL SUBSIDENCE Any soil subsidence or erosion which may occur after the soil filling and prepar

12.0 COMPLETION Notwithstanding anything to the contrary in the Contract, The Landscape Arch Contractor fail to carry out these works within seven (7) days of such a notice, t the Landscape Contractor.

# Landscape: Cover Sheet

remove rubbish that may occur and reoccur throughout the maintenance period. This work shall be carried out ely clean and tidy condition. ny or dead at the Landscape Contractor's cost. Replacements shall be of the same size, quality and species as ect. Replacements shall be made on a continuing basis not exceeding two (2) weeks after the plant has died or is neft or vandalism to the Landscape Architect within one day of them occurring.	Cau CM Can Ere MLG MaS PC PN Tia	Citrus aurantifolia Citrus × meyeri Cupaniopsis anarcadaides Elaeocarpus reticulatus Magnolia 'Littie Gem' Magnolia 'St Marys' Pyrus calleryana 'Capital' Pyrus nivalis Tristaniopsis laurina
ds as necessary or as directed by the Landscape Architect. Remove stakes and ties at the end of the	WS	Waterbousia fioribunda 'Sweeper'
runing will be directed at the maintenance of the dense foliage or miscellaneous pruning beneficial to the naterial shall be removed from the site. be reinstated if necessary to ensure that a depth of 75mm is maintained. Ensure mulch is kept clear of plant	ARW Cja GF Mpon PMM SAB	SHRUBS Azalea 'Red Wing' Comellia japonica Gardenia augusta 'Florida' Murraya poniculata Pittosporum tobira 'Miss Muffet' Syzygium 'Aussie Boomer'
		FEATURES
with all spraying to be carried out in accordance with the manufacturer's directions. Report all instances of Architect prior to spraying.	Aat AN Aze Aau Bau	Agave attenuata Alpinia 'Nutans' Alpinia zerumbet Asplenium australasicum Blechnum nudum
g, weeding, reseeding, rolling, mowing, trimming or other operations as necessary. nd the last mowing, and at times as necessary to maintain healthy grass cover. Carry out last mowing and period. Remove grass clippings from site. Grass and turf areas shall be sprayed with approved selective ct and in accordance with the manufacturer's directions.	Cru CR CGS Dex	Calathea rufibarba Cordyline fruticosa 'Rubra' Ctenanthe 'Grey Star' Doryanthes excelsa
s sward within the 30-75mm range, average 50mm.	Mco Sni Sre	Macrozamia communis Streiktzia nicalal Streiktzia reginae
ual glyphosate herbicide (eg: 'Roundup') in any of its registered formulae, at the recommended maximum rate. ut grassed, planted and mulched areas. Remove weed growth from an area 1000mm diameter around the base of <i>r</i> orks and during the maintenance period.	Aci Cmi Cpe DU	STRAPPY PLANTS Arthropodium cirratum Clivia miniata Crinum pedunculatum Dianella caerulea "Little Jess"
paration operations shall be made good by the Landscape Contractor at no cost to the client.	DSS Hspp Hil	Dianella <sup>1</sup> Silver Streak' Hemerocallis spp Hymenocallis littoralis
vrchitect may instruct the Landscape Contractor to perform urgent maintenance works. Should the Landscape .e, the Principal reserves the right to employ others to carry out such works and charges costs of these works to	LIR LT	Liriope muscari 'Just Right' Lomandra longifolia 'Tanika'
	AAB AA Ade Ael ABB Bco Bu Can Dre Fpu GR GR Gov GPRM Hvi HSC	GROUNDCOVERS AND CLIMBERS Ajuga austrails 'Aussie Bugle' Ajuga reptans 'Artopurpurea' Alternanthera dentata Aspidistra elatior Austromyrtus 'Blushing Beauty' Blechnum cartilagineum Buous sempervirens Cissus antarctica Dichondra repens Ficus pumila Gardenia 'Radicans' Goodenia avota Grevillea poorinda 'Royal Mantle' Hardenbergia vialacea Hibbertia scandens
	Sec. 1	humbers confector

# INDICATIVE PLANT LIST

GROUND FLOOR LANDSCAPE

**GROUND LEVEL GARDENS** 

SCIENTIFIC MAM

Juniperus confer

Kennedia rubicund

Ophiopogan japonic

Pandorea bandorano

Scaevola aemula

Vhe Viola hederacea

Tig

Philodendron 'Xanadu'

Trachelospermum jasminoides

Blue Dwar St Ma Orna Show Wate Carl Carles Weet 1200

Miss Aus Dws She Bird Fish

Cor Cte Giar Bird e Rens Clivia Swan

Spin Aust Bugie Rut Cast Aust Gris Kane Cre Prost Snak Sho Dush Mo Wor

Native Violet

THE SITE-





### LEVEL 3 COURTYARD LANDSCAPE

SCIENTIFIC NAM


COMMON NAME	NATIVE / EXOTIC	AVERAGE MATURE HEIGHT X SPREAD (m)	POT SIZE
Lime Tree	E	3x3	2001
Meyer Lemon	E	6 x 3	200L
Tuckeroo	N	5x4	4006
Blueberry Ash	N	8 x 6	4001
Dwarf Magnolia	E	4×3	400L
St Marys	E	4×3	400L
Ornamental Pear Snow Pear	E	10×3 6×4	4000
snow rear Water Gum	N	6 x 4	4001
Weeping Lify Pily	C N	10×5-8	4001
		-114 PM	
Azalea	E	1×1	
Japanese Camellia	E	5x4	300mm
Gardenia Orange Jasmine	E	1×1 3×2	300mm
Orange Jasmine Miss Muffett Pittosporum	E	3x2	300mm
Aussie Boomer Lily Pily	Ň	1.5 x 1.5	
Agave	E	1×1	300mm
Dwarf Cardamom	E	1×1	300mm
Shell Ginger	E	1×1	( <u>132</u> 27009
Birds Nest Fern	N	1 . 1	300mm
Fishbone Water Fern	N	171	300mm
Furry Feather Calathea	E	0.5 x 0.5 2 x 2	300mm 300mm
Cordyline Ctenanthe 'Grev Star'	E	1-1.5 x 1-1.5	300mm
Gymea Llly	Ň	1×1	
Burrawang	N	1.5 x 1.5	300mm
Giant Bird of Paradise	E	12×4	25
Bird of Paradise	£	1.5 x 1.5	300mm
Renga Renga Lily	E	1×1	150mm
Clivia	E.	1×1	
Swamp Lily	N	1×1	1 1000000000
Paroo Lily Paroo Lily	N	0.5×1 0.5×1	150mm
Day Lily	E	1×1	
Solder Lify	E	0.75 × 1	150mm
Giant Liriope	E	0.5 × 0.5	150mm
Spiny Headed Mat Rush	N	0.5 x 1	150mm
Australian Bugle	N	0.15 x 1	150mm
Bugle	Ę	0.15 x 1 0.5 x 1	150mm
Ruby Leaf Alternanthera Cast Iron Plan	E	0.5×1	150mm 150mm
Austromyrtus	Ň	1.5 × 1	150mm
Gristie Fern	Ň	0.3 x 0.5	150mm
box	E	0.6 x 0.5	150mm
Kangaroo Vine	Ň	climber	150mm
Kidney Weed	N	1×1	150mm
Creeping Fig	E	climber	150mm
Dwarf Gardenia Hop Goodenia	E	0.3 x 0.4 1 x 1	150mm
Prostrate Grevillea	N	0.15 x 5	<ol> <li>CUMPTONS</li> </ol>
Happy Wanderer	Ň	climber	150mm
Snake Vine	N	climber	150mm
Shore Juniper	E	0.4×2	150mm
Dusky Coral Pea	N	climber	150mm
Mondo Grass	E	0.15 x 0.15	150mm
Wonga Wonga Vine	N	climber	150mm
Xanadu Salas San Filmuna	E	1x1	150mm
Fairy Fan Flower Jasmine	N	0.5 x 0.5 climber	150mm 150mm
Jasmine Notive Violet	E.	Climber 0 15 v 1	150mm

N 0.15 x 1 150mm

	TREES	
Can	Cupaniopsis anarcadoides	Tuckeroo
Oeu	Olea europaea	Olive
Pob	Plumeria abtusa	Frangipani
	SHRUBS	
Lst	Lavandula staechas	French Lav
Rof	Rosmarinus officinalis	Rosemary
Sle	Salvia leucantha	Mexican Sa
Wfr	Westringia fruticosa	Coastal Ro
	FEATURES	
Aat	Agave attenuata	Agave
Byu	Beschomeria yuccaides	Mexican Li
Pte	Phormium tenax	NZ Flax
	GROUNDCOVERS & CUMBERS	
Aco	Aptenia cordifalia	Baby Sun F
BBC	Banksia 'Bithday Candies'	Dwarf Ban
Brnu	Brachycome multifida	Cut Leaf D
Cal	Carpobrotus glauscens	Pig Face
Cop	Chrysocephalum apiculatum	Yellow But
Con	Convolvulus cneorum	Silverbush
Cel	Coronidium ellatum	White Pap
Cspp.	Cotyledon spp.	Cotyledon
Cte	Crassula tetragona	Crassula
EVQ	Echeveria 'Violet Queen'	Echeveria
Gto	Gozania tomentosa	Gazania
KPP	Kalanchoe tornentosa 'Panda Plant'	Kalanchoe
LPB	Limonium perezii 'Perezii Blue'	Blue Static
MDM	Mesembryanthemum 'Dwarf Mauve'	Mesembry
Mspp	Mesembryantum spp	Mesembry
Mpa	Myoporum parvifolium	Creeping B
Sgl	Senecio glavcescens	Senecia
Sse	Senecio serpens	Senecio

	NATIVE /	HEIGHT X	-
COMMON NAME	EXOTIC	SPREAD (m)	POT SIZE
Tuckeroo	N	6x4	4001
Olive	E	6x4	200L
Frangipani	Ε	6x4	200L
French Lavender	E	1x1	300mm
Rosemary	E	1x1	300mm
Mexican Sage Bush	Ε	1x1	300mm
Coastal Rosemary	N	1.5x1.5	300mm
Agave	E	1x1	300mm
Mexican Lily	E	1x1	300mm
NZ Flax	E	1.5x1	300mm
Baby Sun Rose	E	0.15 x 1	150mm
Dwarf Banksla	N	0.5 x 1	150mm
Cut Leaf Daisy	N	0.15 x 1	150mm
Pig Face	N	0.15 x 1	150mm
Yellow Buttons	N	0.5 x 1	150mm
Silverbush	E	0.6×1	150mm
White Paper Dalsy	E	1 x 0.3	150mm
Cotyledon		0.15 x 1	150mm
Crassula	E	0.15 x 1	150mm
Echeveria	E	0.15 x 0.15	150mm
Gazania	Ε	0.5 x 1	150mm
Kalanchoe	E	0.3 × 1	150mm
Blue Statice	E	0.3 x 0.5	150mm
Mesembryanthemum	E	0.3 × 1	150mm
Mesembryanthemum	E	0.3 x 1	150mm
Creeping Booblalla	N	0.3×1	150mm
Senecia	E	0.3×1	111 7 6 1 1 1 1 1 1
Senecio	E	0.3×1	150mm


MATURE

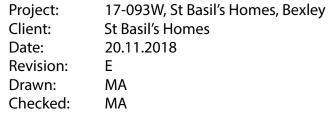


**TaylorBrammer** 

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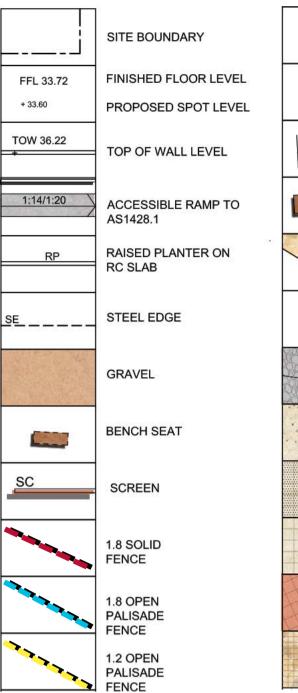



# Landscape: Ground Level Master Plan

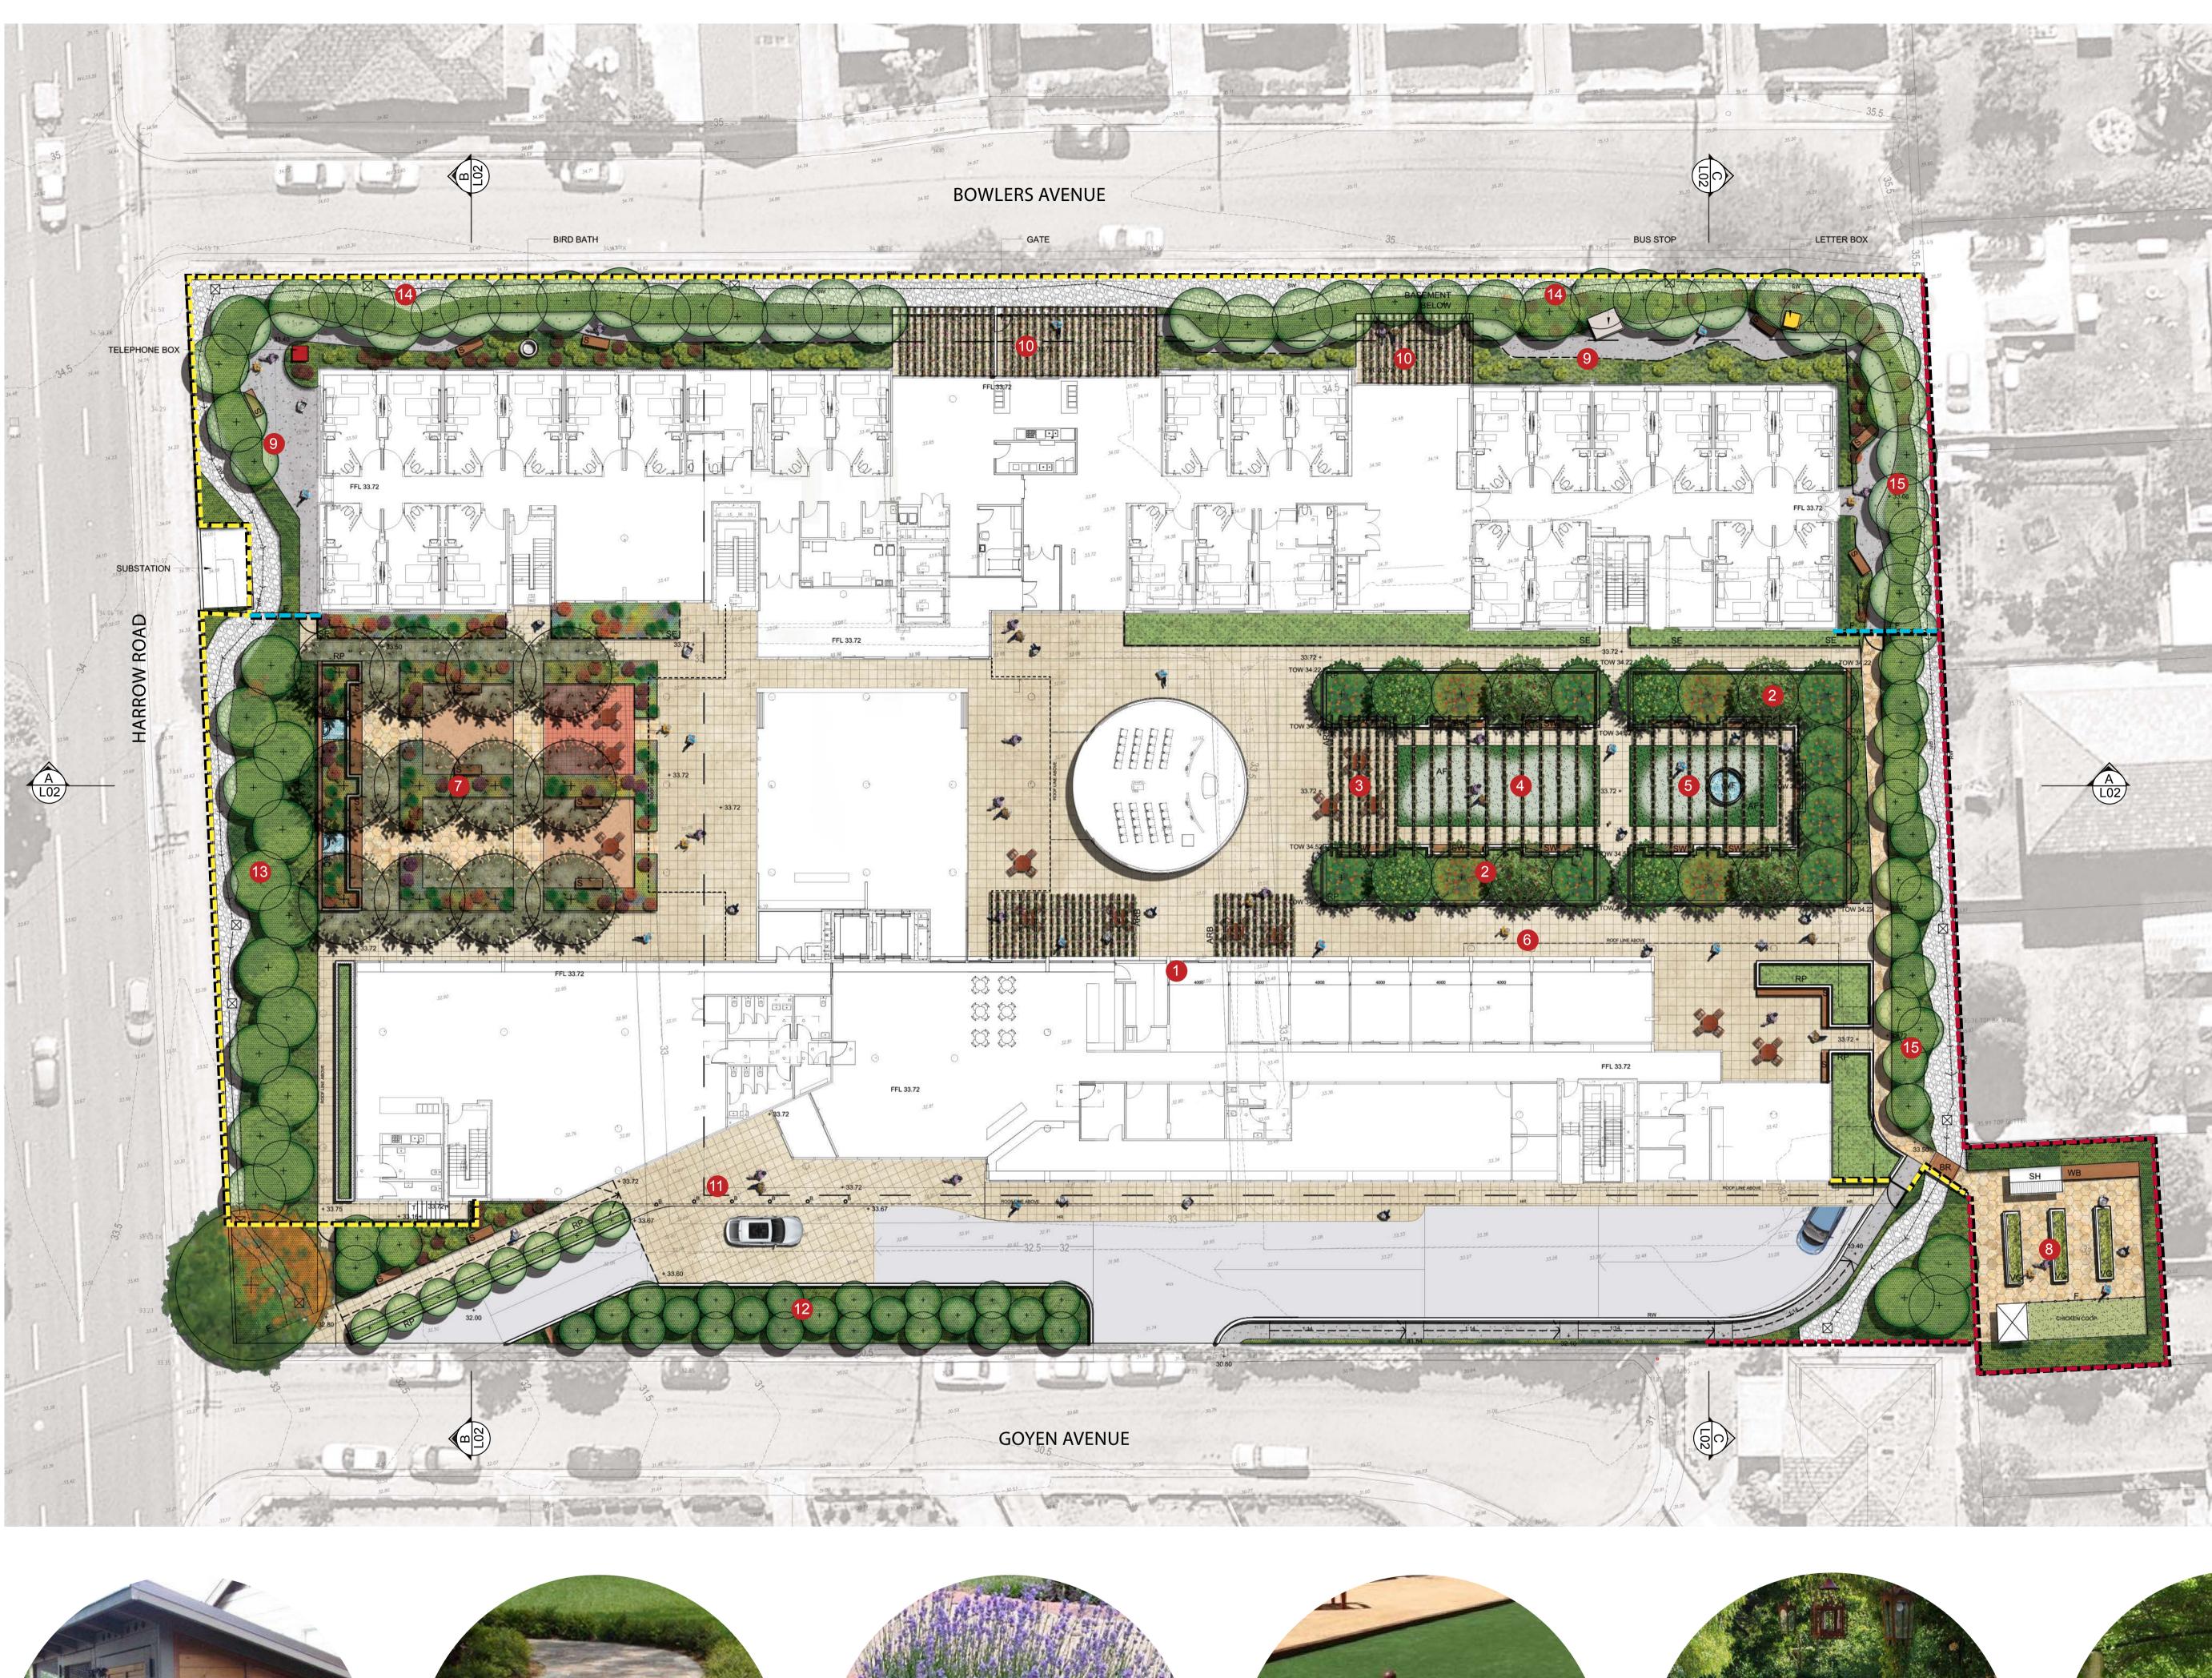
# LEGEND

DIALOGUE

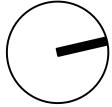the high street.



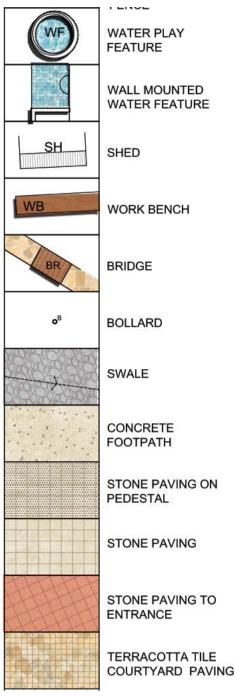

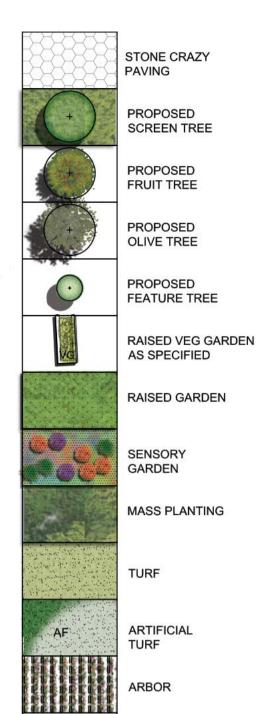


- The dementia gardens are treated with a variety of Mediterranean/Greek shrub and tree species to provide sensual stimulation for residents through plant form , colour and texture. Seating areas are proposed along the edge of the footpath and amongst planted areas creating areas of privacy and relaxation. Covered spill out area provides dementia residents with a space for social and community interaction The entrance into the main foyer is treated with a stone paved shared surface paving incorporating pedestrian footway and vehicular drop off. The paving is orientated to suit the alignment of the building façade and entrance carriageway. Small trees planted in a grid are proposed along Goyen Avenue to provide current residents with a decorative screen treatment. Screen / buffer planting with mature trees and shrubs to provide protection from southerly winds and to prevent 'overlooking' from Harrow Road. Screen / buffer planting with mature trees and shrubs are provided to promote 'privacy screening for residents along eastern boundary overlooking' from Bowlers Avenue. Screen planting along the northern boundary provides a wind barrier and protection for the ground floor plaza and visual screen for existing residents. The below list of tree species mix are to be planted in this area. <u> Botanical</u> <u>Common</u> <u>Name</u> <u>Name</u> Cupaniopsis
  - anacardioides Tuckeroo Elaeocarpus reticulatus Tristaniopsis
  - Waterhousea

laurina

floribunda

Weeping Lily pilly

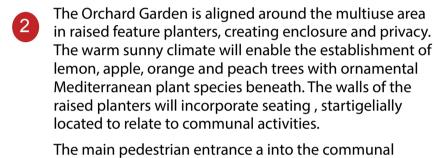

The main pedestrian entrance a into the communal multiuse courtyard is treated with timber arbour structure, which provides a setting for a flexible outdoor eating area.

The open aspect from within the foyer for looks out onto

an entrance plaza that promotes a hype of activity. The

entrance plaza consists of a café spill out space and

promotes social interaction and defines the entrance to

The arbor will continue the length of the courtyard which utilises oversized large timbers, and will be spaced to suit and enhance the geometric form of the Greek theme garden.

The multi-use courtyard consists of an enclosed artificial lawn area that can be used for a variety of functions by all age ranges including:

Performance/ entertainment Places to rest and relax Communal group activities Bocce play Social events

Putting green

Picnic area and BBQs Yoga / Exercise

- 6 A separate artificial grass area has been provided for child play to provide a run-around area for visiting children. The space also caters for the provision of a play water feature which acts as an interactive sculpture and as a focal art feature.
- 6 The high street is a paved walkway that allows the user to access the shops and amonities from the access the shops and amenities from the courtyard.
- 7 The sensory garden is a space for escapism, seclusion and relaxation for day care residents and family. The space is divided geometrically creating separate garden rooms with a Mediterranean/Greek theme concept themes are based upon the 5 senses.
- 8 The communal food garden & chicken coop area provides 'activity' for residential food production.

Project Client: Date: **Revision:** Drawn: Checked:

17-093W, St Basil's Homes, Bexley St Basil's Homes 20.11.2018 MA MA


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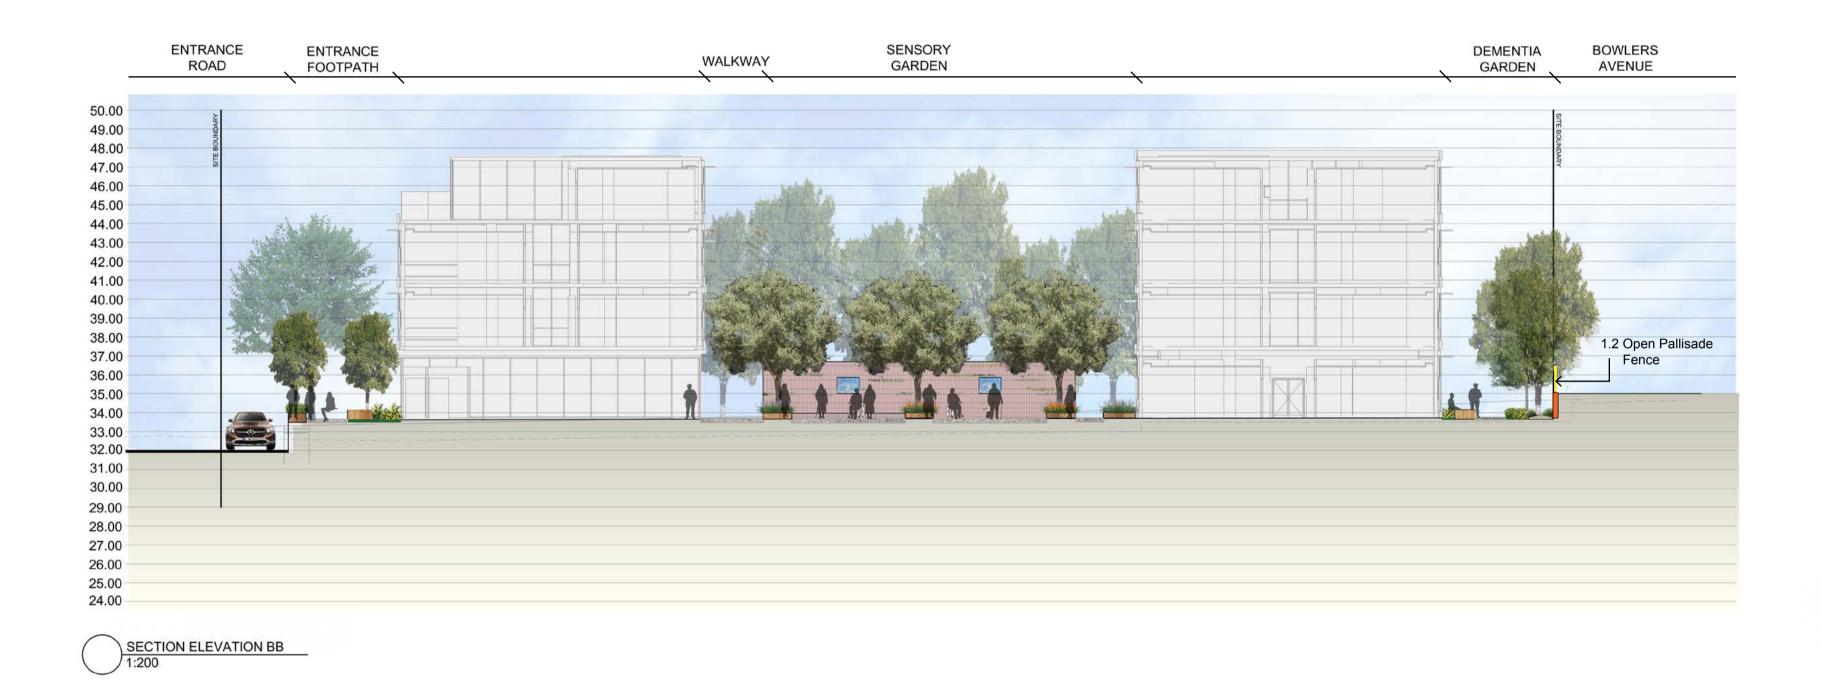
<u>Canopy</u> <u>Spread</u>


<u>Mature</u>


<u>Height</u>




SECTION ELEVATION AA 1:200

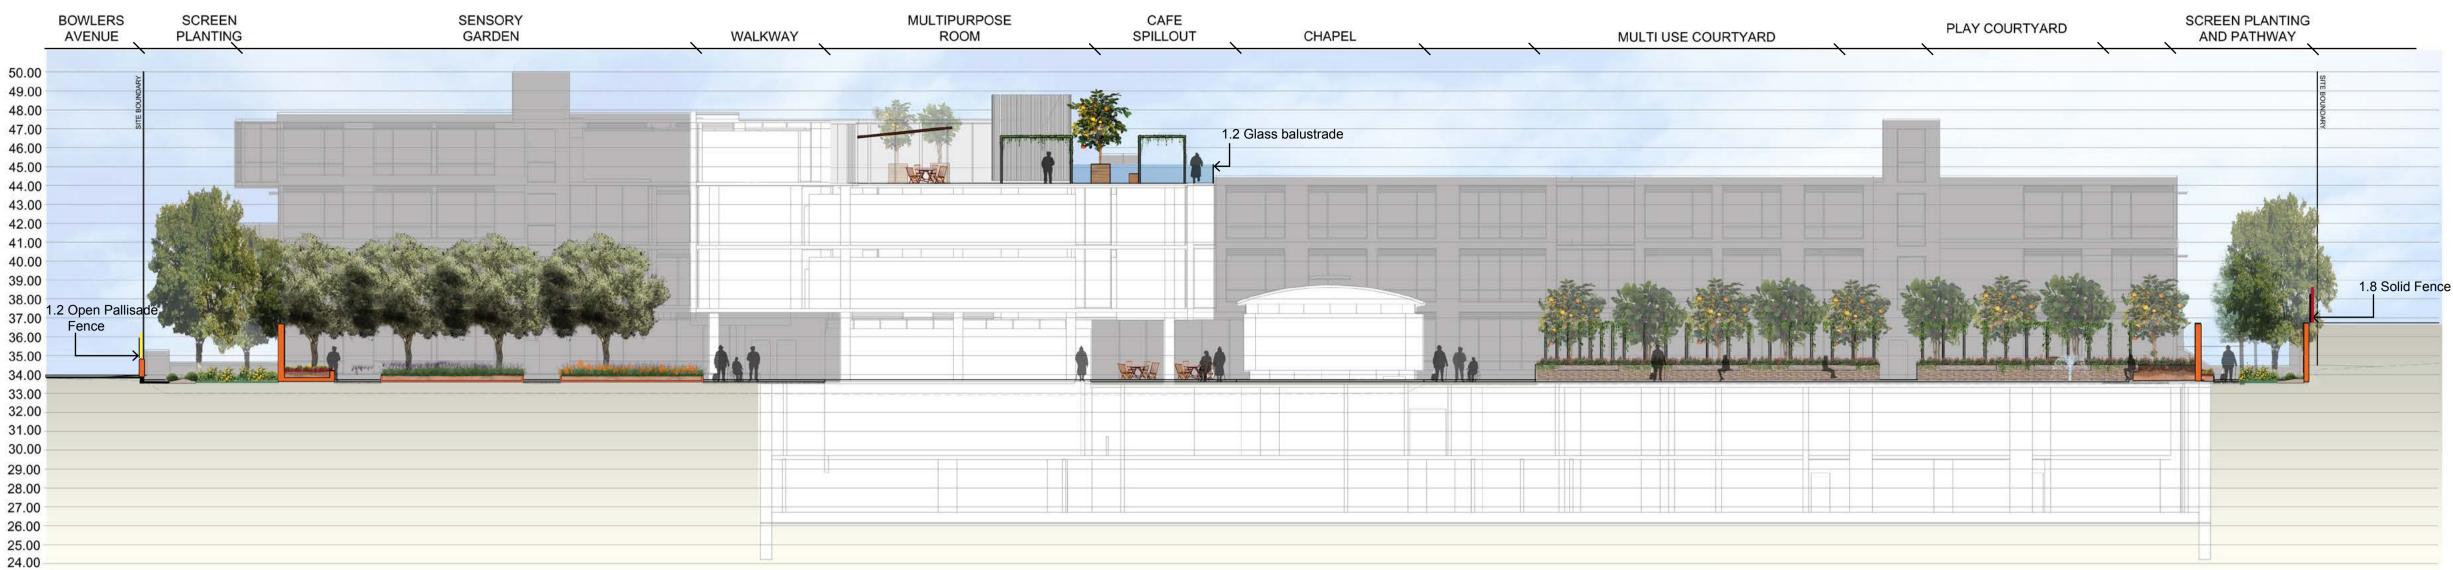

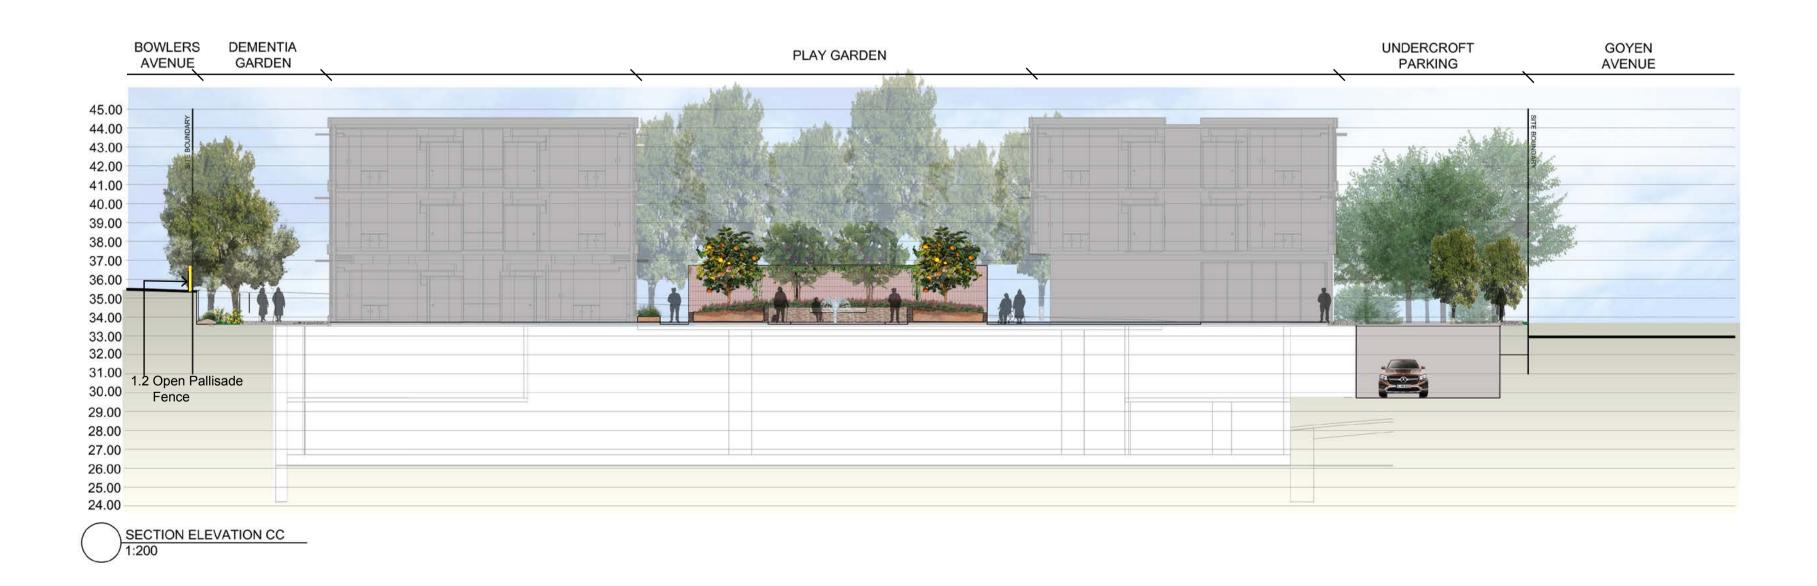

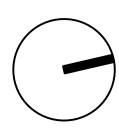

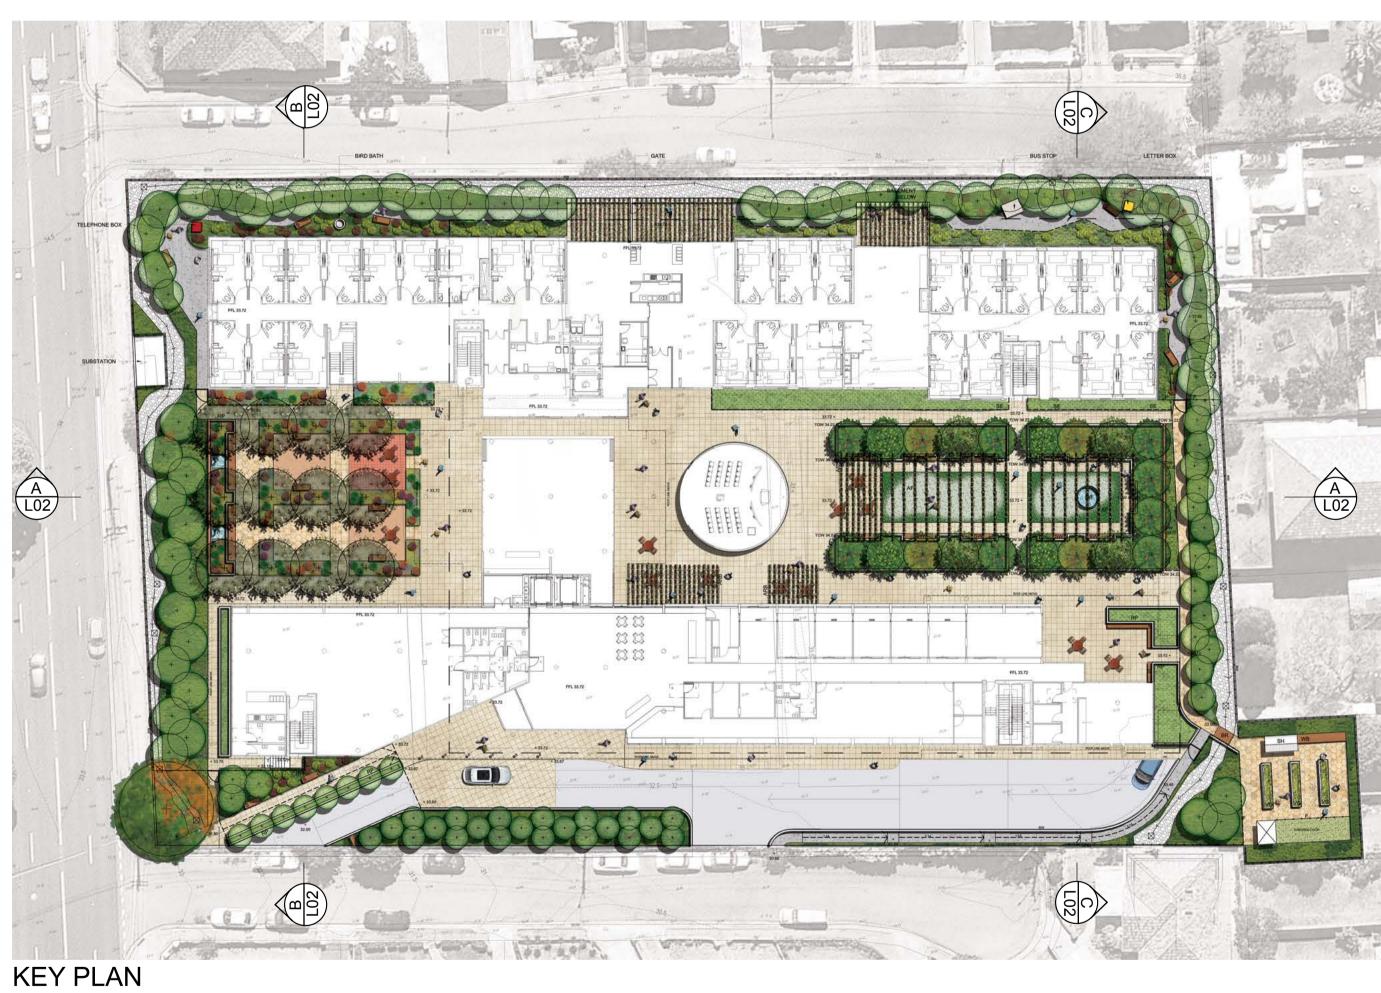

# Landscape: Ground Level Section Elevations

Project:
Client:
Date:
Revision:
Drawn:
Checked:

17-093W, St Basil's Homes, Bexley St Basil's Homes 20.11.2018 MA MA

# TaylorBrammer TAYLOR BRAMMER LANDSCAPE ARCHITECTS PTY LTD

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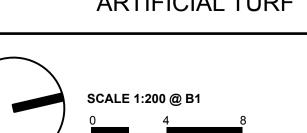










# Landscape: Level 3 Master Plan & Section Elevations



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0				GLASS BA	LUSTRA	DE TO ARCH	HITECT'S	
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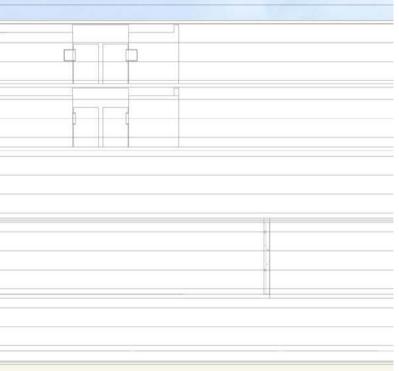


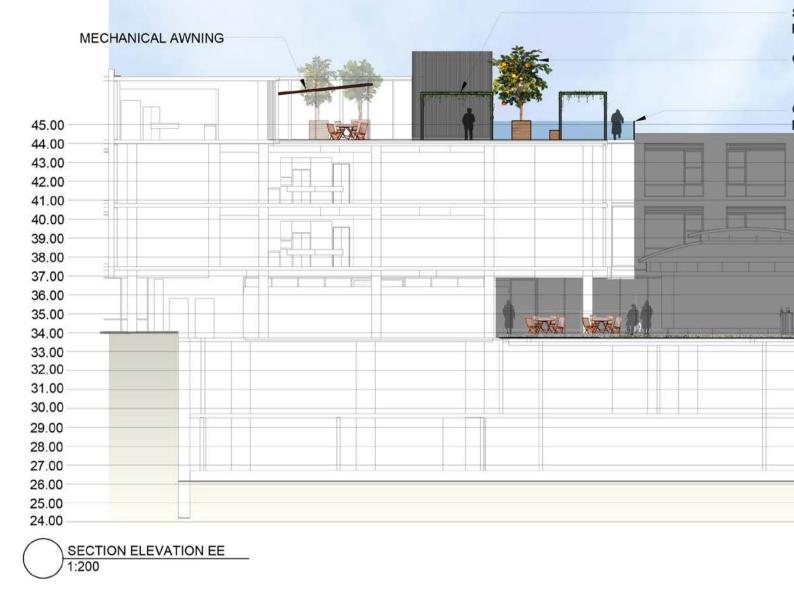		<u>**</u>	ORCHARD/FRUIT T	REE IN TIMBER PLANTER
	• · ·		GLASS BALUSTRAD	DE TO ARCHITECT'S
		I		
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2				
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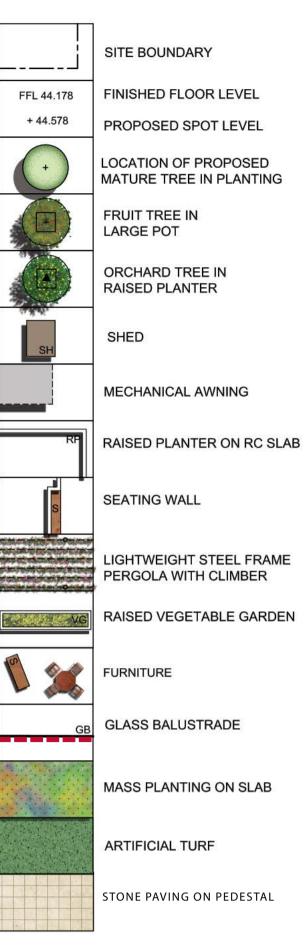


# STEEL FRAME PERGOLA WITH CLIMBING PLANTER ORCHARD/FRUIT TREE IN TIMBER PLANTER

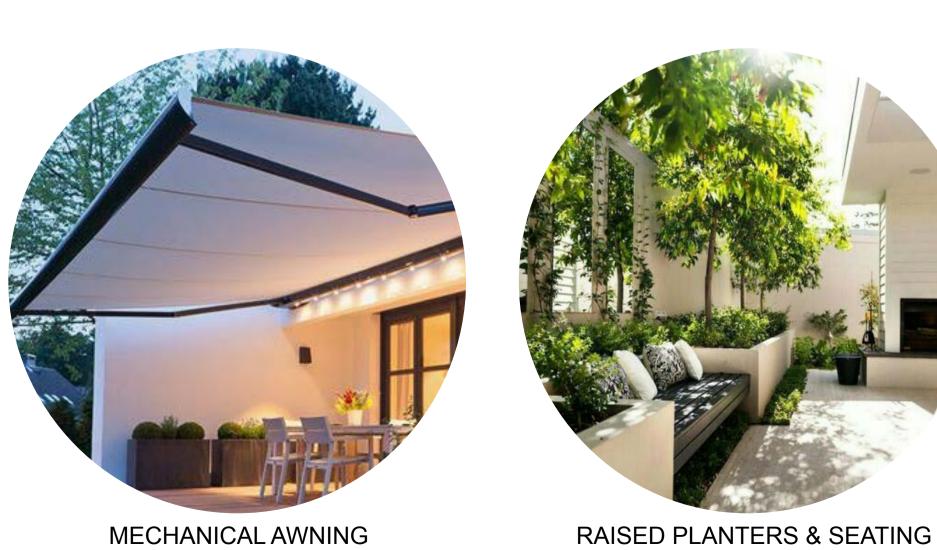
GLASS BALUSTRADE TO ARCHITECT'S DETAIL



# LEGEND



# DIALOGUE

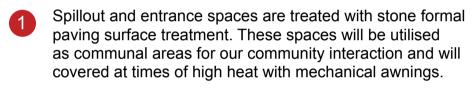

2 Raised planters with are treated with species that will provide all year round colour and interest a, as well as being able to maintain healthy growth in a high level heat environment.

3 Specimen fruit trees in large timer planters and pots are provided in modular units that can be moved to make a flexible space.

4 Artificial turf areas are proposed as an alternate treatment to breakup the paved surface.

6 A feature pergola with climbing plants is located within the central courtyard to provide an alternate covered seating area. This is an essential feature of the courtyard during summer periods of high heat.

6 Raised community vegetable garden area provides 'activity' for residential food production.




Project: Client: Date: **Revision:** 

17-093W, St Basil's Homes, Bexley St Basil's Homes 20.11.2018 Drawn: MA Checked: MA

**TaylorBrammer** 


TAYLOR BRAMMER LANDSCAPE ARCHITECTS PTY LTD SOUTH COAST OFFICE 26 Moore Street, NSW, 2515 E southcoast@taylorbrammer.com.au T 61 2 4267 5088 Copyright of Taylor Brammer Landscape Architects Pty Ltd. ABN 61 098 724 988




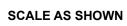






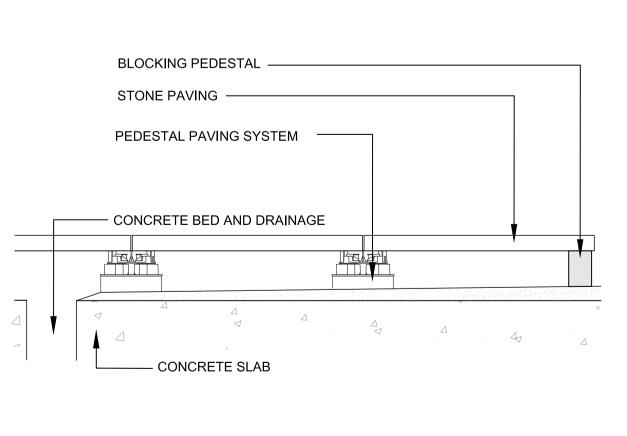


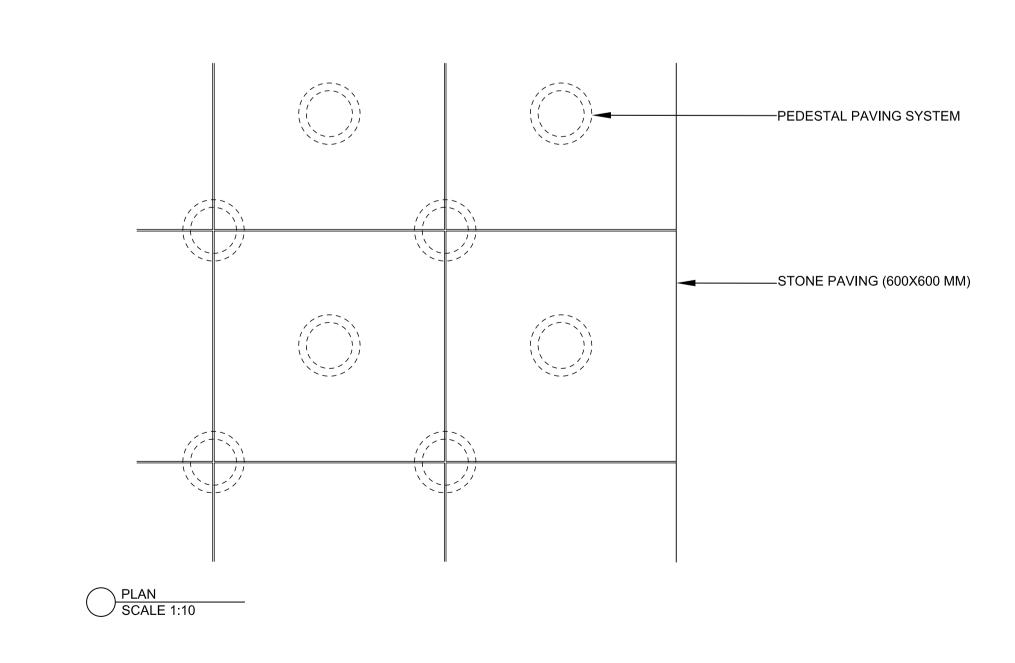


# **RAISED PLANTER** 2 **TYPICAL SECTION 1:10**

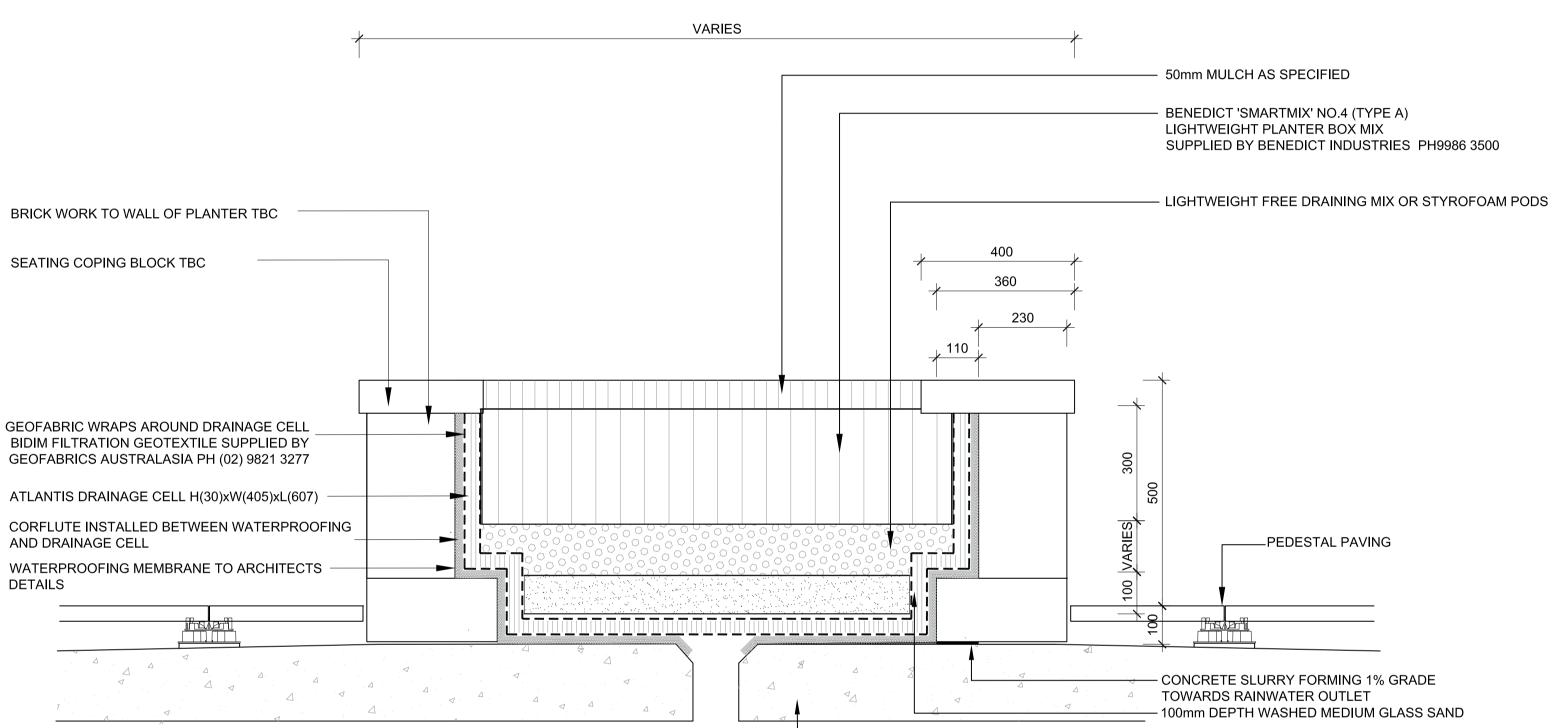

# MATURE TREE PLANTING IN MASS PLANTING ON NATURAL GROUND TYPICAL SECTION 1:20

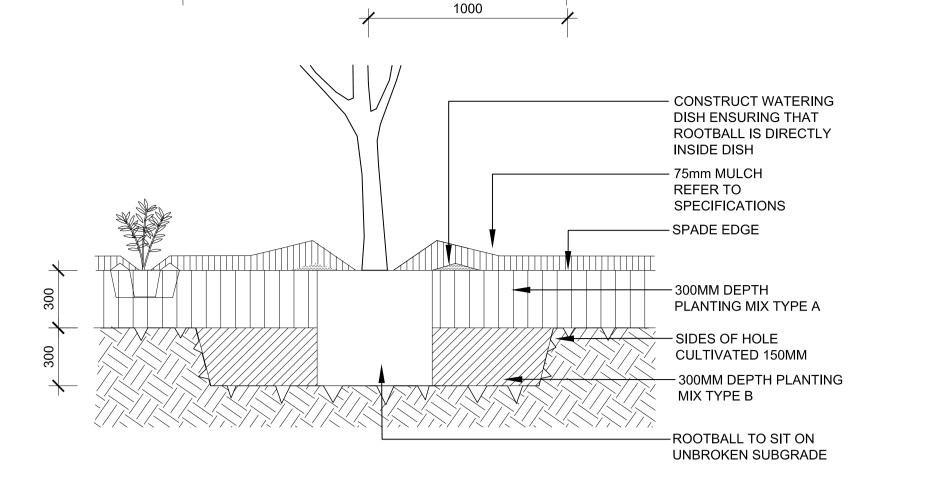

2000

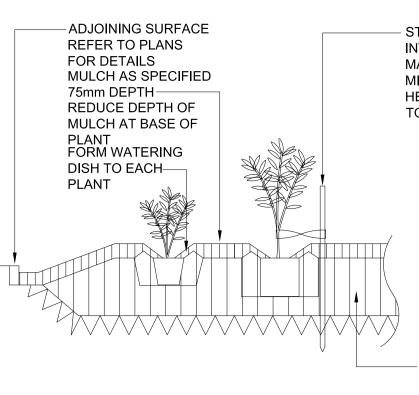


STAKE AND TIE AS SPECIFIED. DRIVE INTO GROUND ON WIND WARD SIDE. MAX. HEIGHT 900mm CLEAR OF BED MIN. 600mm INTO GROUND 50mm HESSIAN TIE IN FIG. 8 STAPLED TO STAKE


PREPARATION 1. REMOVE ALL BUILDERS SPOIL & RUBBISH FROM AREA TO BE PLANTED 2. EXCAVATE PLANTING BED TO 300 DEPTH 3. CULTIVATE SUBGRADE TO 150mm DEPTH AND INCORPORATE ADDITIVES AS SPECIFIED 4. INSTALL 300mm OF PLANTING MIX TYPE A AS SPECIFIED THOROUGHLY ROTARY HOE INTO BROKEN UP SUBGRADE

### MASS PLANTING BED ON NATURAL GROUND 4 TYPICAL SECTION 1:20


— CONCRETE SLAB REFER TO ENGINEERS DETAIL

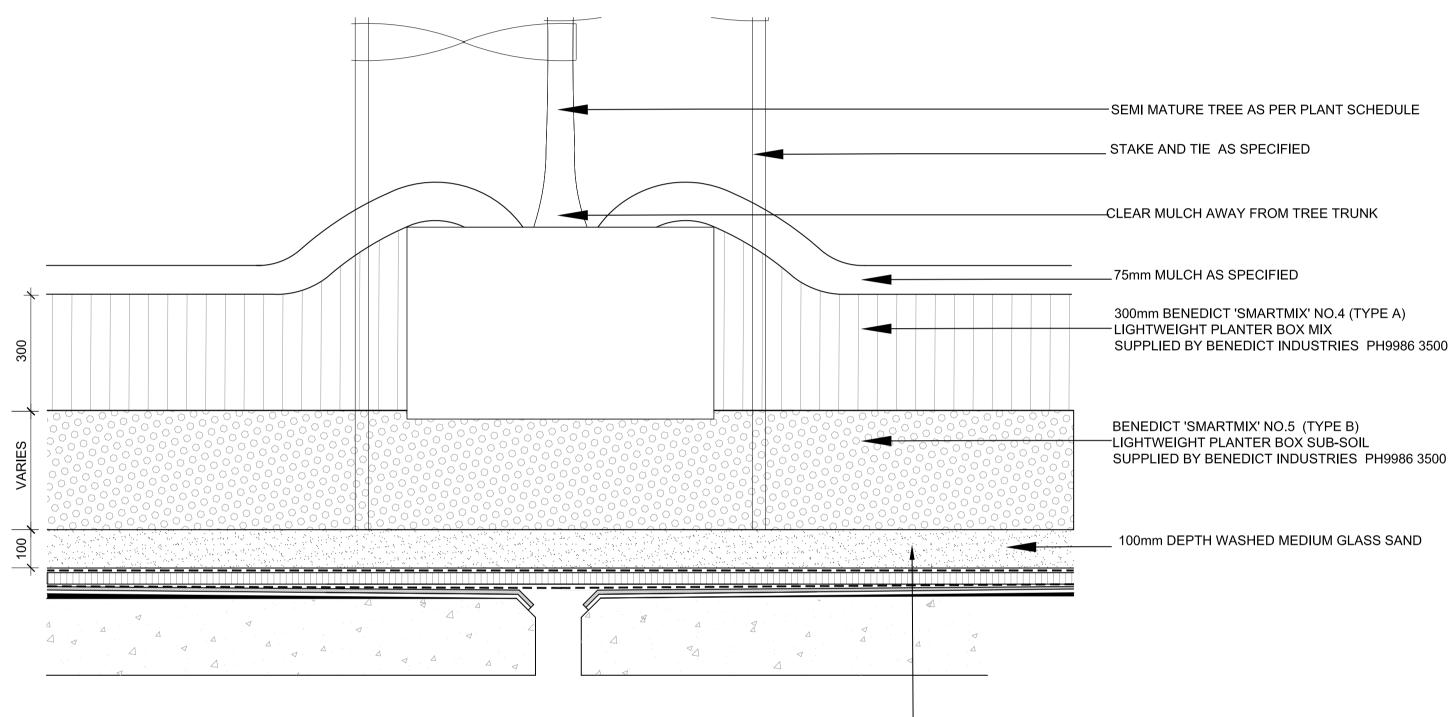

6

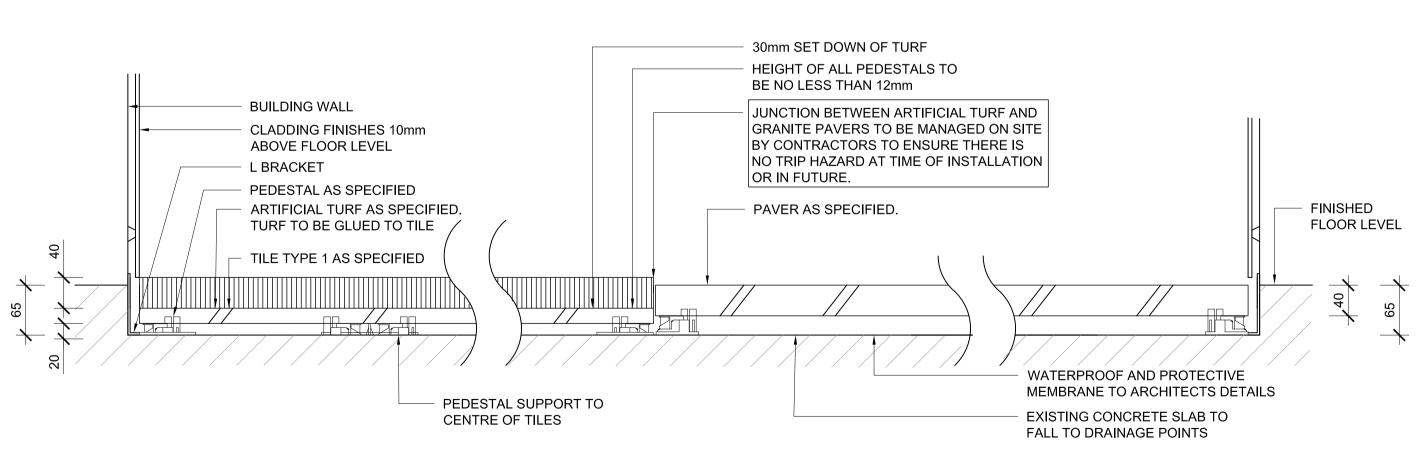



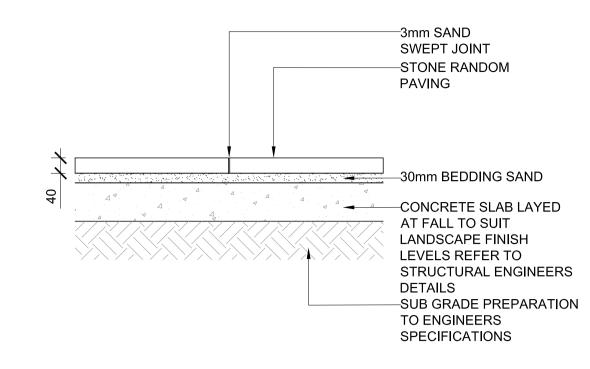

### STONE PAVING ON GROUND 5 **TYPICAL SECTION 1:10**

## — 100mm DEPTH WASHED MEDIUM GLASS SAND

# MATURE TREE PLANTING IN RAISED PLANTER **TYPICAL SECTION 1:10**

# **PEDESTAL PAVING AND SYNTHETIC TURF DETAIL** TYPICAL SECTION 1:5

Project:	17
Client:	St
Date:	20
Revision:	Е
Drawn:	Μ
Checked:	Μ

7-093W, St Basil's Homes, Bexley t Basil's Homes 20.11.2018

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